
2 5


WINDOW REPAIRS BUILDING 1


PHILADELPHIA NAVAL BUSINESS CENTER PHILADELPHIA, PENNSYLVANIA

NAVAL FACILITIES ENGINEERING COMMAND ~ MID-ATLANTIC HAMPTON ROADS IPT, PUBLIC WORKS DEPARTMENT NORFOLK PROJECT MANAGEMENT AND ENGINEERING BRANCH

LOCATION PLAN	GOVERNING REGULATIONS	GENERAL NOTES		an D. Alu-		
	BUILDING CODE	1. WHERE EXISTING STRUCTURES TO REMAIN ARE DAMAGED DUE	SHEET NO.	NAVFAC DWG. NO.	SHEET TITLE	FOR COMMANDER NAVFAC DATE 8 - 01 - 0
1070	UNIFIED FACILITIES CRITERIA (UFC) 1—200—01 (31 JULY 2002) INTERNATIONAL BUILDING CODE (IBC) 2000	TO NEW CONSTRUCTION OR DEMOLITION REQUIRED BY THESE DOCUMENTS, THE CONTRACTOR SHALL REPAIR THE DAMAGED			GENERAL	T. GALLAGHER
	ACCESSIBILITY CODE	ITEM(S) WITH NEW MATERIALS TO MATCH THE ADJACENT MATERIAL, TEXTURE, AND COLOR.	1 G-001	12,510,746	COVER SHEET	ACTIVITY - SATISFACTORY TO 07/30/0
565	UNIFORM ACCESSIBILITY STANDARDS (UFAS) AMERICANS WITH DISABILITIES ACT (ADA)	2. FIELD VERIFY EXISTING DIMENSIONS GIVEN, PRIOR TO ORDERING			ARCHITECTURAL	DES JMS DRW JMS REVIEWED BY RER PM/DM JMS
Mr. Apr 1. 200 PSF	ACCESSIBILITY GUIDELINES FOR BUILDINGS AND FACILITIES (ADAAG)	MATERIALS OR BEGINNING DEMOLITION.	2 A-001	12,510,747	ARCHITECTURAL SYSMBOLS, LEGENDS AND ABBREVIATIONS	chief eng/arch J.HASTE, P.E
	MECHANICAL CODE	3. THE CONTRACTOR SHALL OBSERVE AND MAINTAIN BUILDING AND	3 A-201 4 A-202	12,510,748 12,510,749	SOUTH AND EAST ELEVATIONS NORTH AND WEST ELEVATIONS	ENGINEERING COMMAND WID-ATLANTIC - NORFOLK, VIRGINIA ADELPHIA, PA
PROJECT SITE Sign Sign Sign Sign Sign Sign Sign Sign	INTERNATIONAL MECHANICAL CODE (IMC) 2000	COMPOUND SECURITY REQUIREMENTS AS DIRECTED BY THE CONTRACTING OFFICER.	5 A-501	12,510,749	WINDOW SCHEDULE AND GENERAL NOTES	A S S S S S S S S S S S S S S S S S S S
SIIE SIIE 778	ELECTRICAL CODE		6 A-502	12,510,751	WINDOW DETAILS	ERING ATLA
554	NFPA 70, NATIONAL ELECTRIC CODE	4. THE GENERAL SCOPE OF WORK INCLUDES, BUT IS NOT LIMITED TO REPAIR OF EXISTING HISTORIC WOOD WINDOWS.	7 A-503	12,510,752	WINDOW AND DOOR ELEVATIONS	DEL DEL
200 PSF	PLUMBING CODE		8 A-901	12,510,753	REFERENCE PHOTOGRAPHS	TATION - NO PHILADE
29 199	INTERNATIONAL PLUMBING CODE (IPC) 2000	5. NEW WORK WILL BE ACCOMPLISHED IN AND AROUND AREAS	9 A-902	12,510,754	REFERENCE PHOTOGRAPHS	—————————————————————————————————————
545 1 545 1 566 1 5		WHICH WILL REMAIN OPERATIONAL. ACCORDINGLY, MEASURES SHALL BE TAKEN TO AVOID INTERFERENCE WITH THE	10 A-903 11 A-904	12,510,755 12,510,756	REFERENCE PHOTOGRAPHS REFERENCE PHOTOGRAPHS	AL FACILITI MAND NAVAL STA PUIL SUIL TO STA PUIL PUIL PUIL PUIL PUIL PUIL PUIL PUIL
Sign Sign Sign Sign Sign Sign Sign Sign	FIRE PREVENTION & LIFE SAFETY CODE UNIFIED FACILITIES CRITERIA (UFC) 3-600-01 (15 DEC 2002)	OPERATIONAL WORK ROUTINE.	12 A-905	12,510,757	REFERENCE PHOTOGRAPHS	
633	NFPA 101, LIFE SAFETY CODE	6. ALL ITEMS NOT NOTED AS "EXIST" SHALL BE PROVIDED UNDER	13 A-906	12,510,758	REFERENCE PHOTOGRAPHS	
		THE REQUIREMENTS OF THIS CONTRACT.	14 A-907	12,510,759	REFERENCE PHOTOGRAPHS	
619 645 946 945 PAR 949 949 949 949		7 ALL CUDAITTALS DECLUDED BY THESE DLANS OF SPECIFICATIONS				ERING PAIR PAIR PAIR PAIR PAIR PAIR PAIR PAIR
PARKING 83 GGT FILE OF THE PARKING BY PARKIN		7. ALL SUBMITTALS REQUIRED BY THESE PLANS OR SPECIFICATIONS SHALL BE SUBMITTED TO THE CONTRACTING OFFICER FOR				
567 567 567 567 567 567 567 567 567 567		APPROVAL PRIOR TO COMMENCEMENT OF RELATED WORK.				S ENGINE WD NORFOLK JSINESS (
17 19 10 10 10 10 10 10 10 10 10 10 10 10 10		8. THE CONTRACTOR LAYDOWN AREA SHALL BE COORDINATED WITH				
		THE CONTRACTING OFFICER PRIOR TO THE PRECONSTRUCTION				
18 10 12 7 0 11 12 7 0 11 12 7 0 11 12 7 0 11 12 7 0 11 12 7 0 12 7 0 12 7 0 12 7 0 12 12 7 0 12 12 12 12 12 12 12		MEETING. THE ALLOWABLE AREA SIZE SHALL BE ESTABLISHED BY THE CONTRACTING OFFICER.				F THE NAVY ACILITIE OS IPT ~ PU AVAL BU
1 A S N T D O R T V E D O R T		BI THE CONTINUE CITICEN.				
25 B 3 D 26 Best too. 16 D 360 560 560 560 560 560 560 560 560 560 5						A P P P P P P P P P P P P P P P P P P P
						HILL
(2) Part (3)						AA PE
WHARF 4-B						CODE ID. NO. 80091 SIZE D SCALE: AS NOTED
PER 1						MAXIMO NO. N/A STA. PROJ. NO. N/A
DELAWARE NI						work order no. 573091
DELAWAY N						constr. contr. no.
pirR-5 pieR-4						NAVFAC DRAWING NO.
PER-5						12,510,746 SHEET 1 OF 14
						G-001

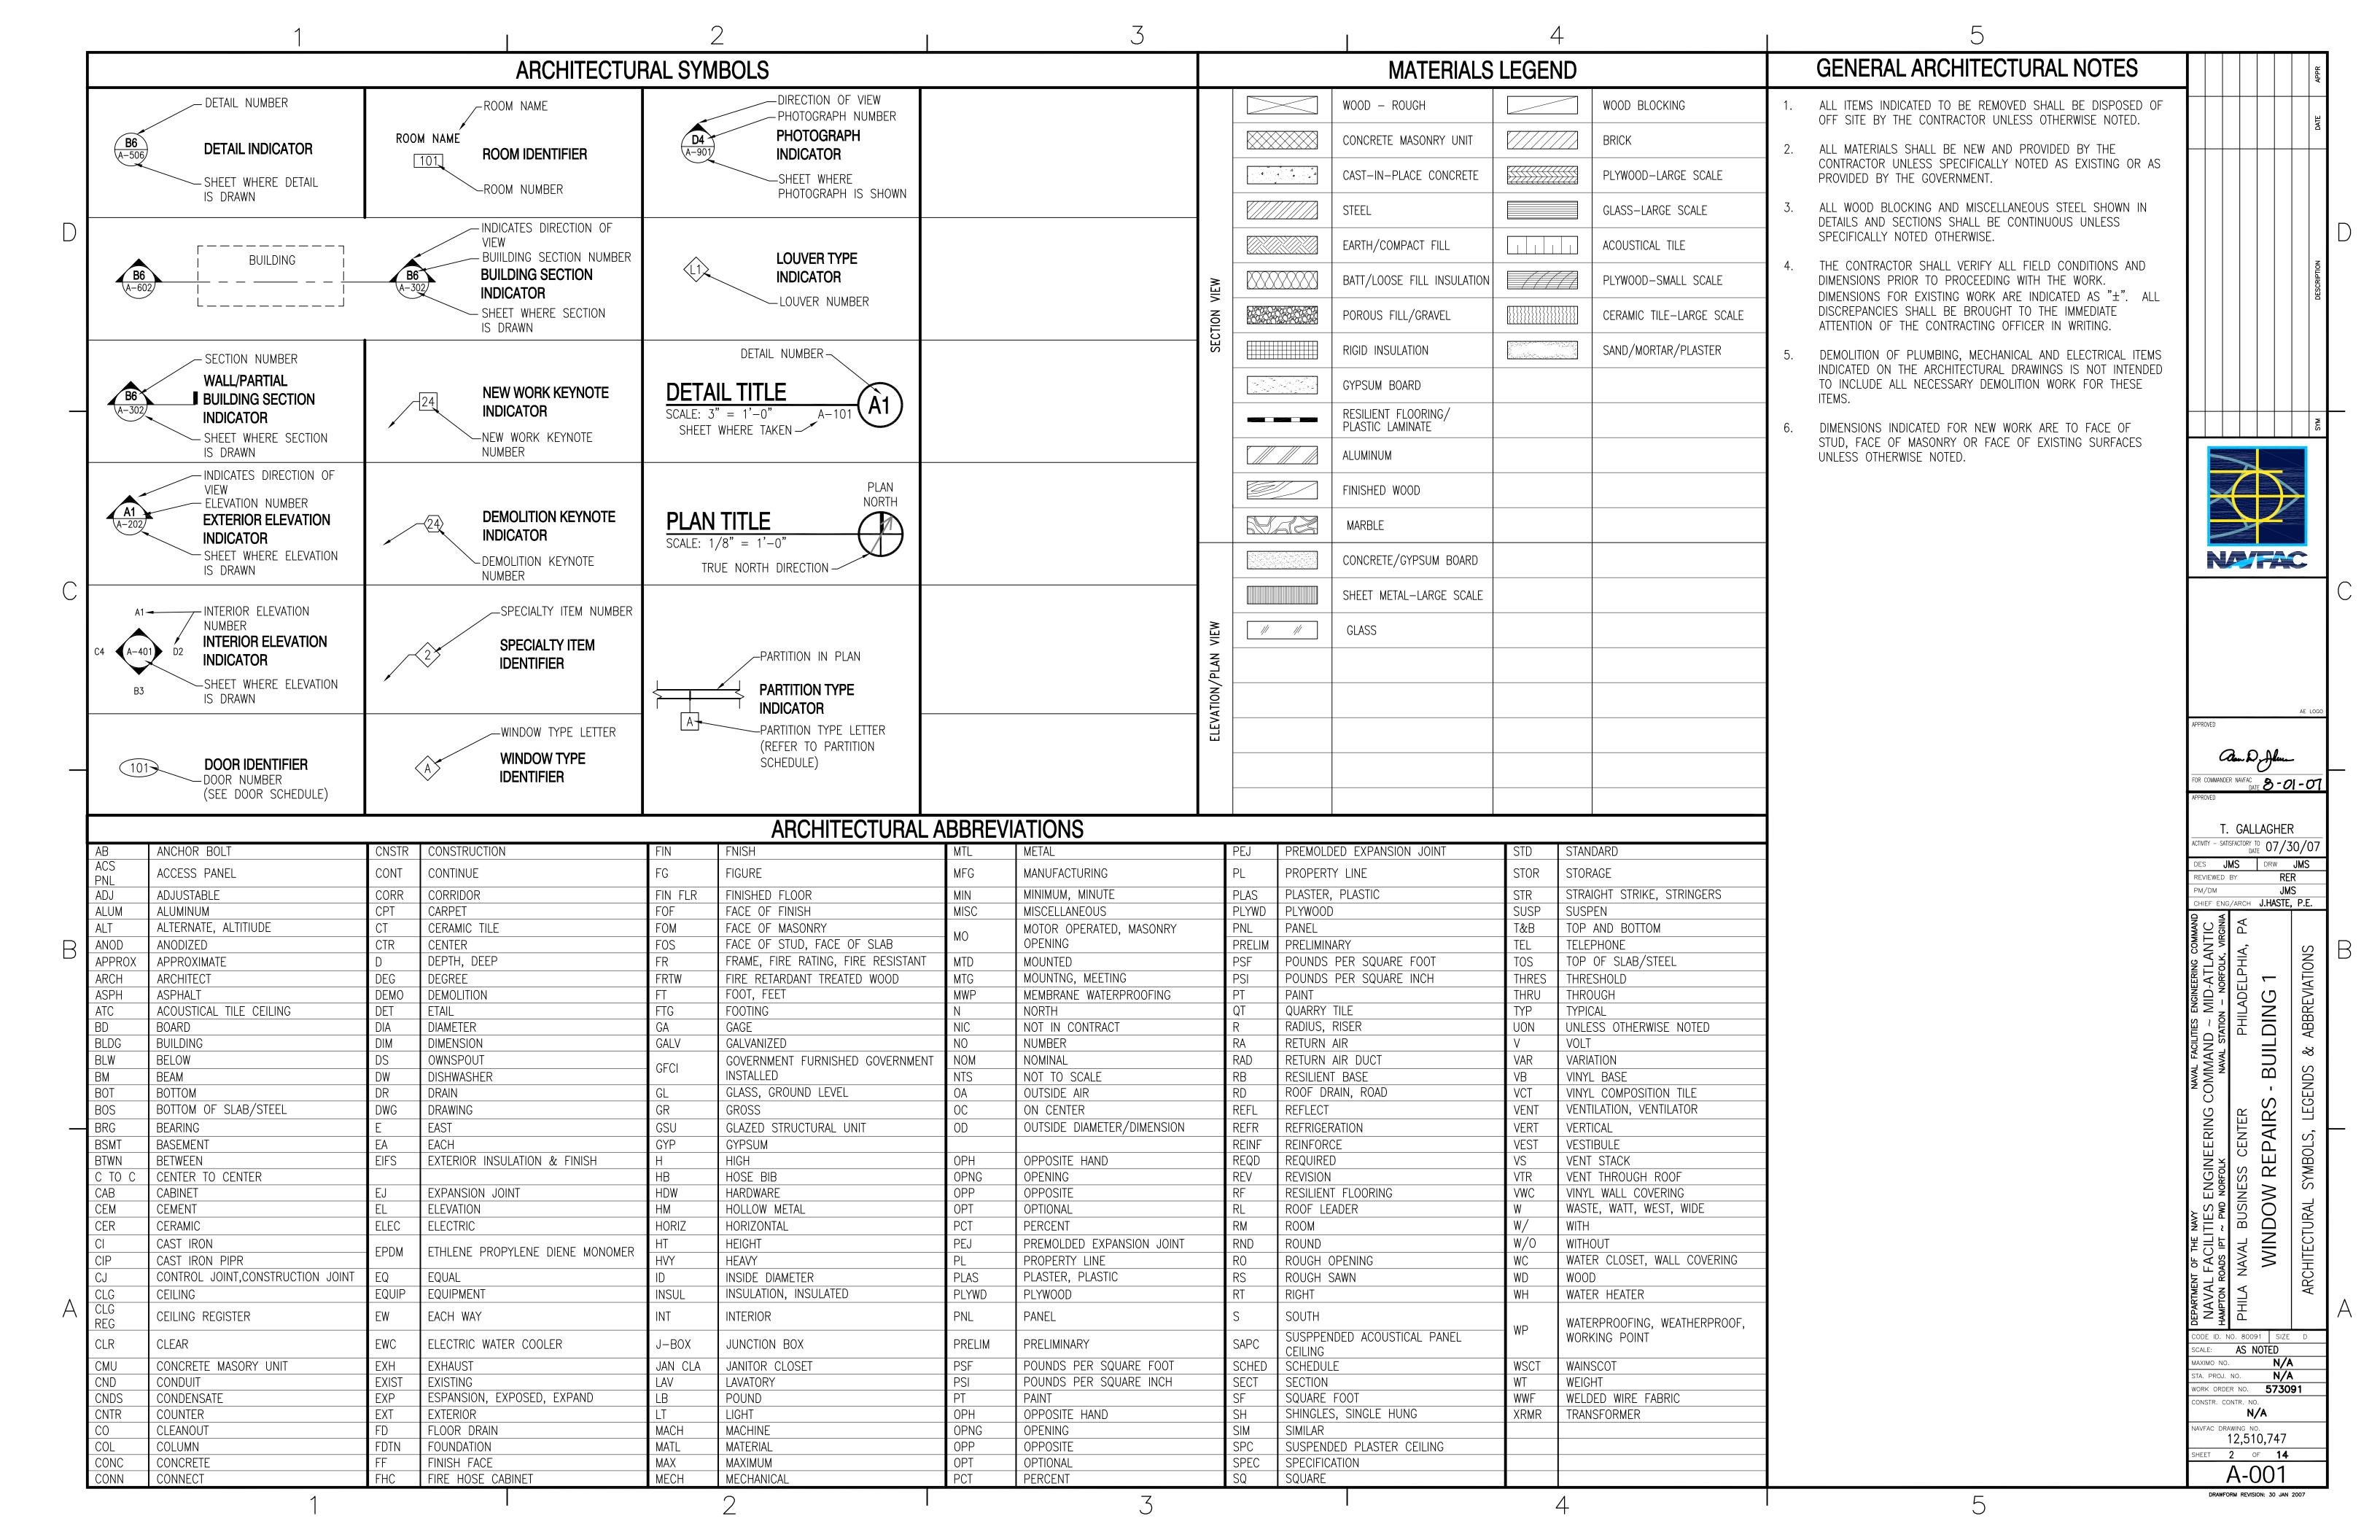

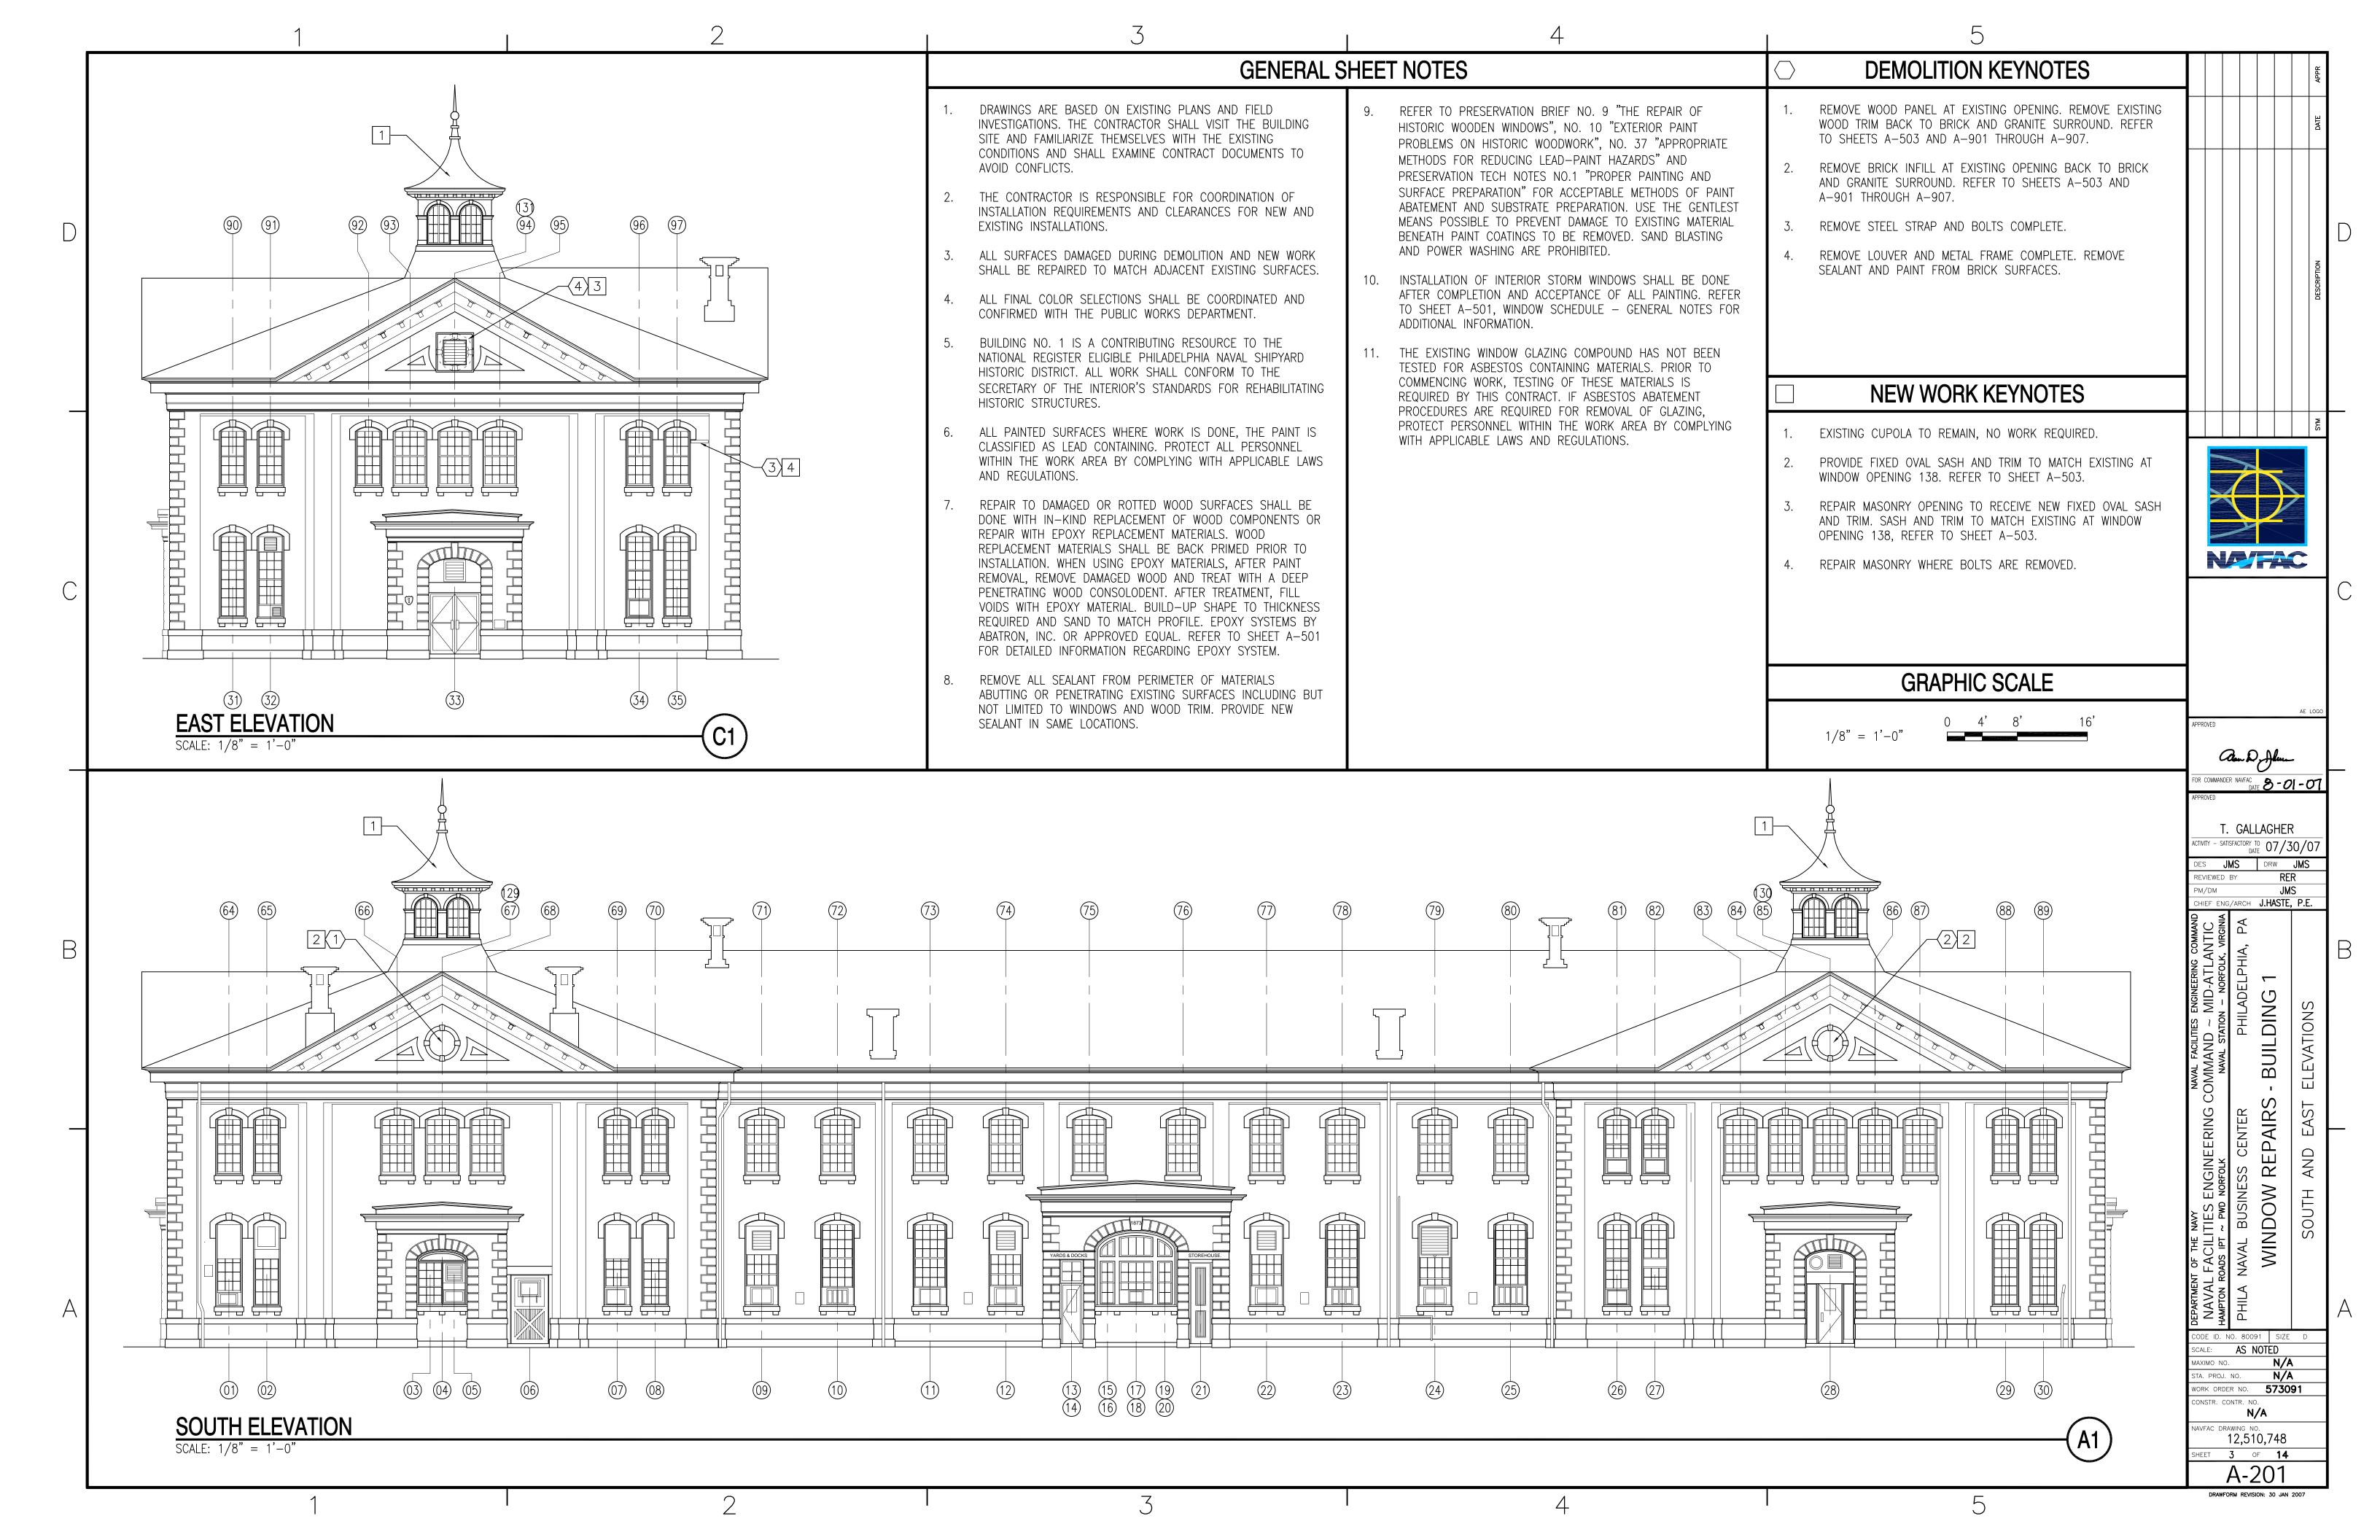

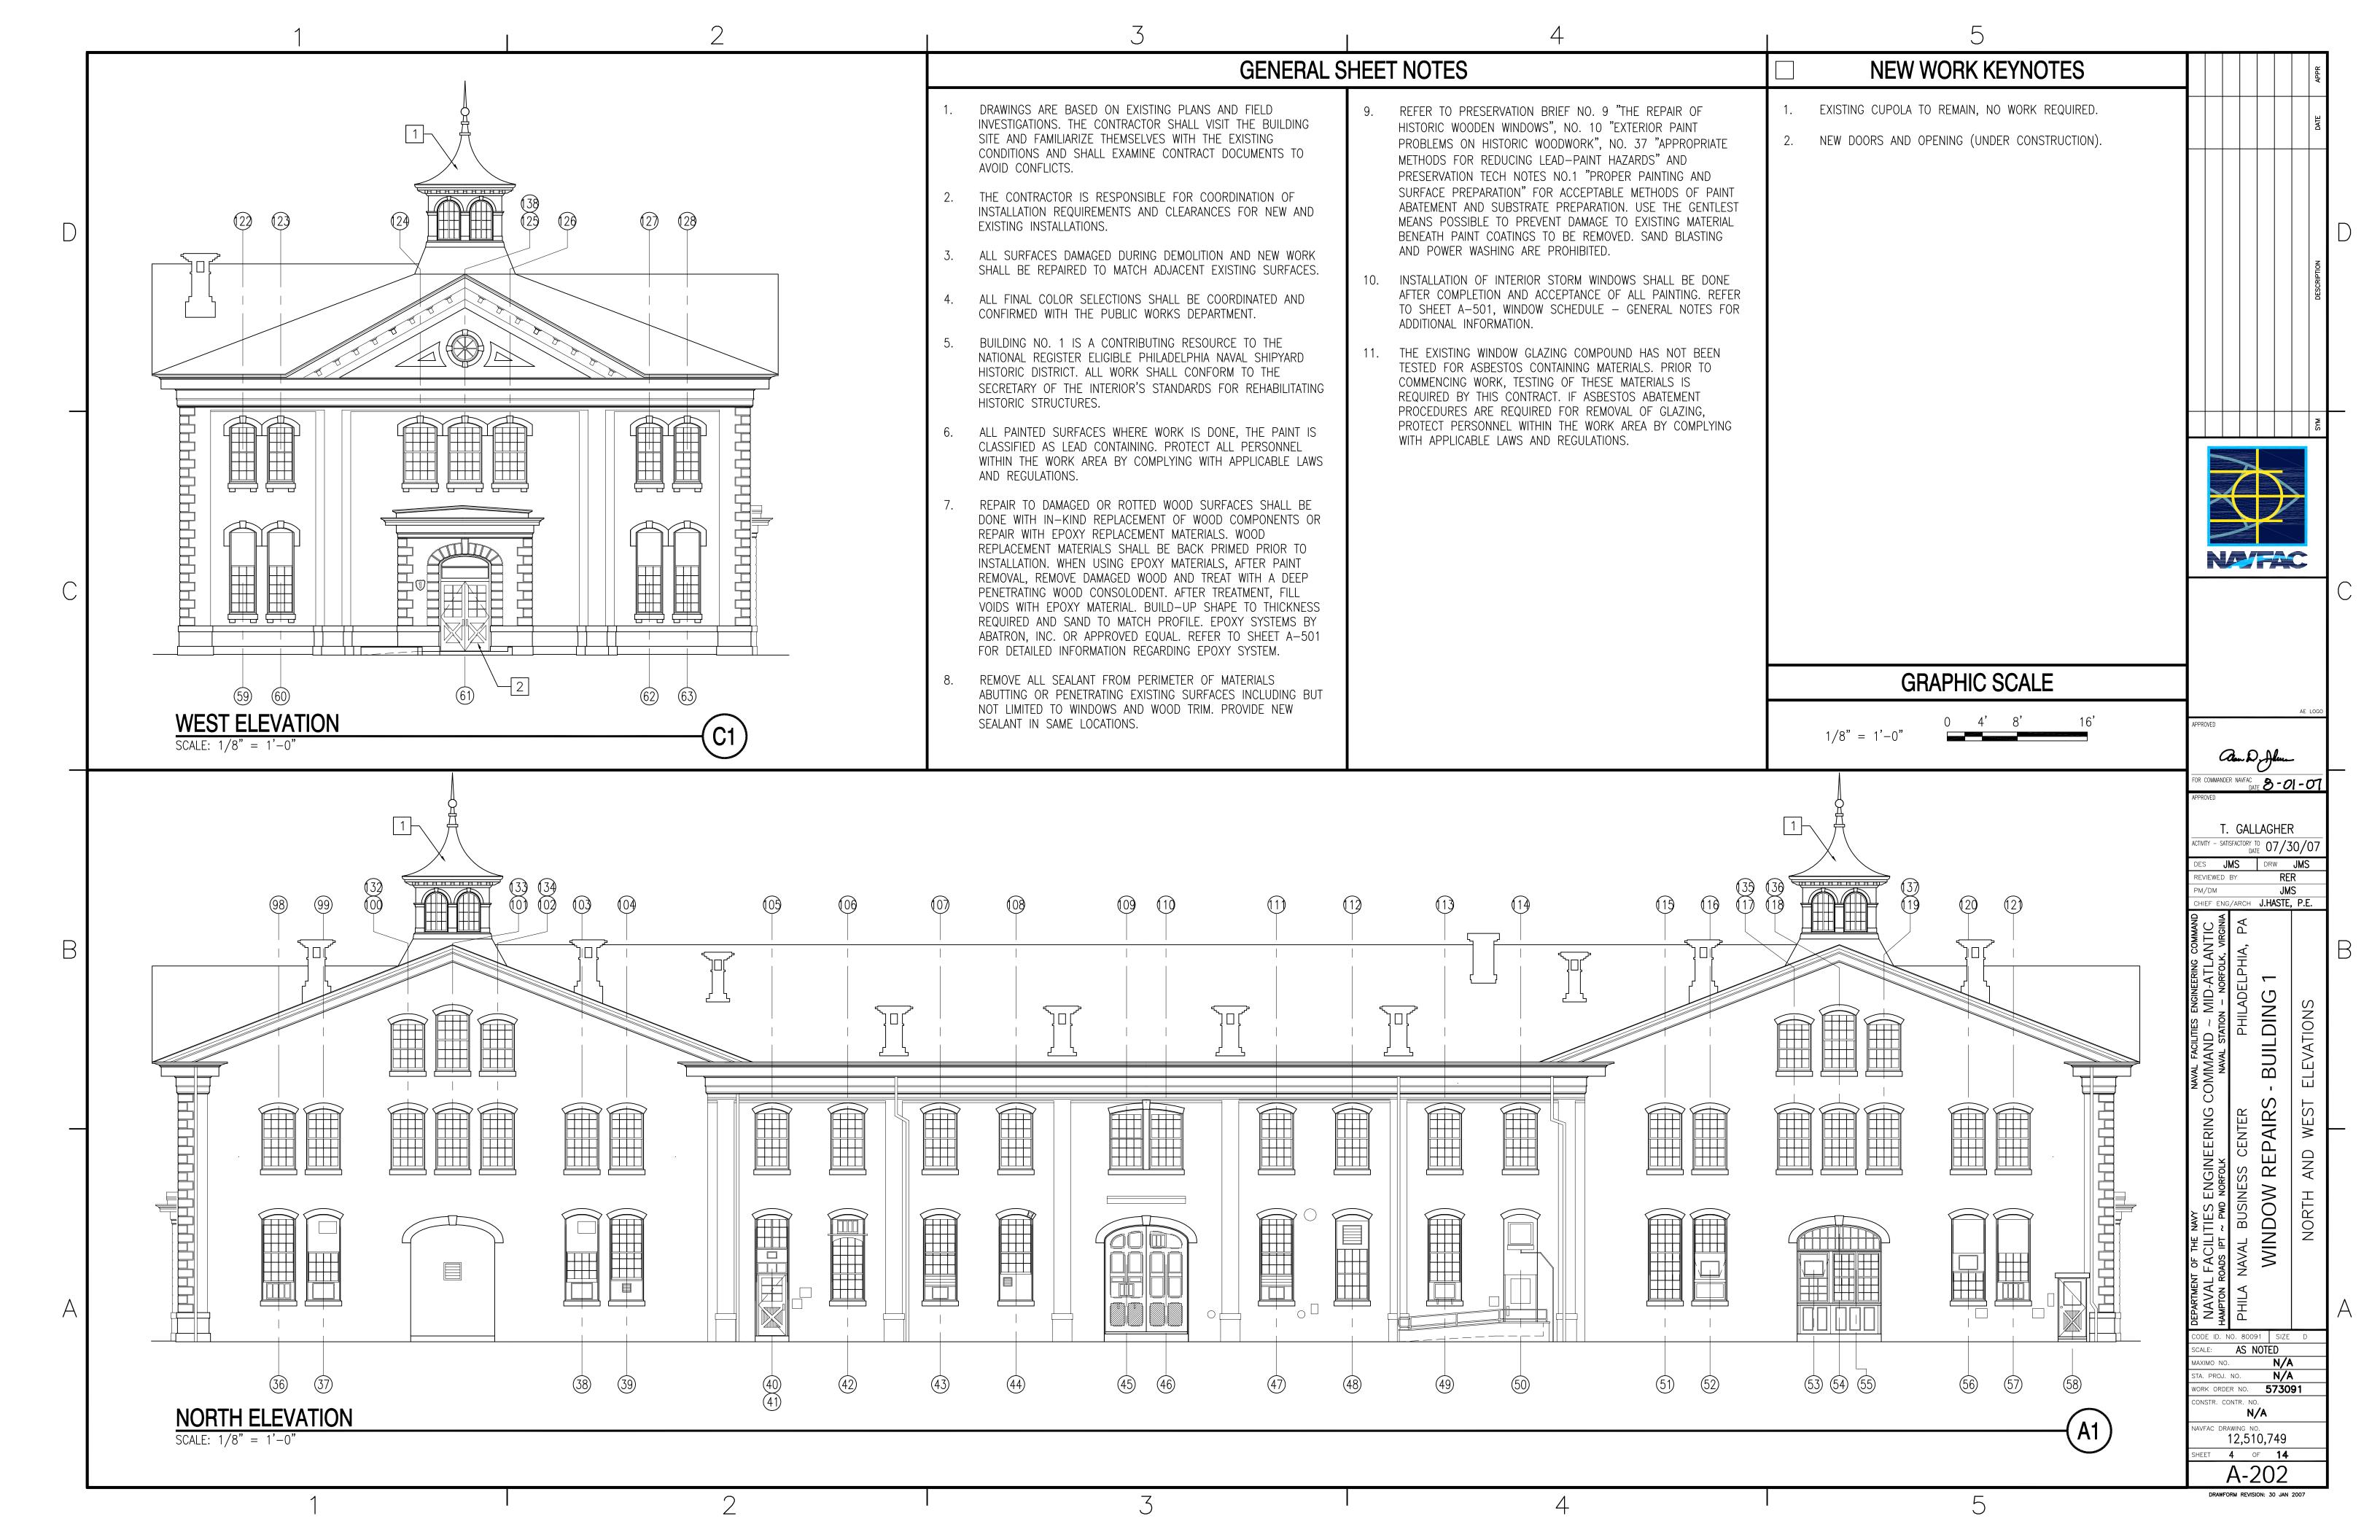

WINDOW SCHEDULE					WINDOW SCHEDULE - SPECIFIC NOTES		GENERAL NOTES -	WINDOW REPAIR				
MARK WINDOW SIZE		WINDOW LITES			WINDOW SIZE	WINDOW TYPE	LITES SPECIFIC NOTES	1. EXISTING DOOR, REFER TO SHEET A-503 AND SHEETS A-901	1.	NOMINAL SASH OPENING SIZE IS INDICATED ON THE WINDOW	14. AT THE WINDOWS, THE CONTRACTOR SHALL ASSUME THAT THE	
) - 3	2'-8" X 10'-0" 2'-8" X 10'-0" 2'-8" X 5'-0"	DH 12/15 DH 12/15 DH 9/6	2, 3	79 3'- 80 3'-	7-8" X 7'-0" 7-8" X 7'-0" 7-8" X 7'-0"	DH DH	12/12 12/12 9/9	THROUGH A-907 FOR SPECIFIC WORK REQUIREMENTS. 2. REMOVE EXISTING UPPER SASH COMPLETE. PROVIDE UPPER SASH TO FIT OPENING, SASH PROFILE TO MATCH EXISTING	2	SCHEDULE. TO OBTAIN EXACT DIMENSIONS, SASH PROFILES, AND FRAME PROFILES, FIELD MEASURE. REFER TO BUILDING ELEVATIONS FOR WINDOW DESIGNATIONS.	REQUIRED SASH WEIGHTS ARE PRESENT IN THE WEIGHT POCKET. IF THE WEIGHTS ARE NOT PRESENT, NOTIFY THE CONTRACTING OFFICER. ACCESS TO THE WEIGHT POCKETS IS TYPICALLY FOUND BY REMOVAL OF AN ACCESS PANEL AT THE	
	1'-8" X 5'-4" 2'-8" X 5'-0"	FFS 1 DH 9/6	2 4 2, 3	82 2'- 83 3'-	7-8" X 7'-0" 7-8" X 7'-0"	DH DH DH	9/9 12/12	HISTORIC WINDOWS. 3. REMOVE EXISTING LOWER SASH COMPLETE. PROVIDE LOWER	3.	WINDOWS ON THE SCHEDULE ARE EXISTING U.O.N.	WINDOW JAMB THAT IS HELD IN PLACE BY SCREWS. 15. ALL SASH CHAINS SHALL BE REPLACED. INSTALL SASH CHAINS	
	2'-8" X 10'-0" 2'-8" X 10'-0"	DH 12/15 DH 12/15	2	85 3'- 86 3'-	7-8" X 7'-0" 7-8" X 7'-0" 7-8" X 7'-0"	DH DH	12/12 12/12 12/12	SASH TO FIT OPENING, SASH PROFILE TO MATCH EXISTING HISTORIC WINDOWS.	4.	ALL FABRIC WINDOW TREATMENTS AND DRAPES WILL BE REMOVED BY THE GOVERNMENT PRIOR TO BEGINNING OF WINDOW REPAIR WORK. REMOVE AND DISPOSE OF ALL 2"	RATED FOR THE SPECIFIC WINDOW SASH WEIGHT. 16. READJUST EXISTING AND/OR NEW WINDOW STOPS, SASHES,	
)	3'-8" X 10'-0" 3'-8" X 10'-0" 3'-8" X 10'-0"	DH 16/20 DH 16/20 DH 16/20	2, 3 3 3	88 2'- 89 2'-	7-8" X 7'-0" 7-8" X 7'-0" 7-8" X 7'-0"	DH DH DH	12/12 9/9 9/9	 REPAIRS TO EXISTING WINDOW DONE IN-PLACE, REMOVAL OF WINDOW NOT REQUIRED. RETAIN PATTERNED GLASS AT BOTTOM SASH. 		VENETIAN BLINDS AND 1" MINI-BLINDS INCLUDING ALL HARDWARE, FASTENERS AND RELATED EQUIPMENT AT FIRST FLOOR WINDOWS, REMOVE ROLLING BLINDS AND STORE FOR REINSTALLATION. REFER TO	AND HARDWARE TO PROVIDE PROPER ALIGNMENT AND OPERATION OF ALL WINDOWS AND TO REDUCE DRAFTS. REMOVE PAINT COMPLETE FROM PULLEYS AND CLEAN WEIGHT POCKETS OF ANY OBSTRUCTIONS. THIS WORK IS ABOVE AND BEYOND	
	3'-8" X 10'-0" 3'-0" X 2'-8" 	DH 16/20 FS 4 	2, 3 4 1	91 2'-	7-8" X 7'-0" 7-8" X 7'-0" 7-8" X 7'-0"	DH DH DH	9/9 9/9 9/9	6. REMOVE FIXED AND CASEMENT WINDOWS BUILT INTO EXISTING WOOD DOOR COMPLETE. REFER TO SHEET A-503 AND SHEETS	5.	WINDOW DETAILS ON SHEET A-502. REMOVE AND DISPOSE OF ALL EXISTING STORM WINDOWS,	ANY WORK SPECIFICALLY NOTED IN THE WINDOW SCHEDULE, SPECIFIC NOTES OR OTHER GENERAL NOTES.	
	2'-0" X 2'-0" 2'-0" X 6'-0" 3'-8" X 3'-0"	FFS 2 DH 4/4 FFS 4	4	94 3'-	7-8" X 7'-0" 7-8" X 7'-0" 7-8" X 7'-0"	DH DH DH	12/12 12/12 12/12	A-901 THROUGH A-907 FOR SPECIFIC WORK REQUIREMENTS. 7. EXISTING FIXED WOOD DOOR TO REMAIN IN-PLACE. REFER TO SHEET A-503 AND SHEETS A-901 THROUGH A-907 FOR		FRAMES, PANELS AND FASTENERS PRIOR TO COMMENCING WINDOW REPAIR WORK. PROVIDE INTERIOR MOUNTED ALUMINUM STORM WINDOWS AND PANELS FOR THE SECOND FLOOR WINDOWS ONLY. PROVIDE WOOD EXTENSION STRIPS AS	17. AFTER ALL WINDOW REPAIRS HAVE BEEN COMPLETED, CLEAN THE INTERIOR AND EXTERIOR SIDE OF WOOD WINDOWS AND FRAMES. CLEAN THE INTERIOR AND EXTERIOR SIDES OF THE NEW STORM WINDOWS AND PANELS PRIOR TO AND AFTER	
	3'-8" X 6'-0" 2'-0" X 2'-0" 2'-0" X 6'-0"	DH 8/8 FFS 2 DH 4/4	3 4	97 2'-	7-8" X 7'-0" 7-8" X 7'-0" 7-8" X 7'-0"	DH DH DH	9/9 9/9 12/12	SPECIFIC WORK REQUIREMENTS. 8. EXISTING WOOD DOORS TO REMAIN (NEW CONSTRUCTION).		NECESSARY TO PROVIDE FOR ADEQUATE ATTACHMENT OF INTERIOR STORM WINDOWS AND PANELS. THE MEETING RAIL OF THE STORM WINDOW SHALL ALIGN WITH THE MEETING RAIL OF	INSTALLATION. 18. BUILDING NO. 1 IS A CONTRIBUTING RESOURCE TO THE	
) -	3'-8" X 10'-0" 3'-8" X 10'-0"	DH 16/20 DH 16/20	1, 7 2, 3	99 3'- 100 3'-	7-8" X 7'-0" 7-8" X 7'-0" 7-8" X 7'-0"	DH DH	12/12 12/12 12/12 3 12/12	9. EXISTING WOOD REPLACEMENT SASH TO REMAIN.		THE WOOD WINDOW. REFER TO WINDOW DETAILS ON SHEET A-502.	NATIONAL REGISTER ELIGIBLE PHILADELPHIA NAVAL SHIPYARD HISTORIC DISTRICT. AS A REFERENCE, USE THE U.S. DEPARTMENT OF THE INTERIOR PRESERVATION BRIEF NO. 9 — "THE REPAIR OF HISTORIC WOODEN, WINDOWS" AND	
	3'-8" X 10'-0" 3'-8" X 10'-0"	DH 16/20 DH 16/20	2, 3	102 3'- 103 3'-	7-8" X 7'-0" 7-8" X 7'-0"	DH DH	12/12 12/12 12/12	 10. OVAL SASH TO MATCH EXISTING WINDOW 138. 11. LOUVER AT OVAL OPENING, REFER TO SHEET A-503 AND SHEETS A-901 THROUGH A-907 FOR SPECIFIC WORK 	6.	REMOVE EXISTING INTERIOR WOOD STOP AND PARTING BEAD TO ACCOMMODATE REMOVAL OF UPPER AND LOWER SASH FOR REPAIRS. REPLACE INTERIOR WOOD STOP AND PARTING BEAD IN-KIND, MATCH EXISTING PROFILES AS CLOSE AS POSSIBLE.	"THE REPAIR OF HISTORIC WOODEN WINDOWS" AND PRESERVATION BRIEF NO. 10 — "PAINT PROBLEMS ON HISTORIC WOODWORK". PERFORM ALL CONSTRUCTION IN A MANNER THAT WILL NOT RESULT IN AN ADVERSE IMPACT ON THE HISTORIC	
	2'-8" X 10'-0" 2'-8" X 10'-0" 	DH 12/15 DH 12/15 	3	105 3'- 106 3'-	7-8" X 7'-0" 7-8" X 7'-0" 7-8" X 7'-0"	DH DH	12/12 12/12 12/12	REQUIREMENTS. 12. FIX BOTH CASEMENT SASH IN-PLACE AFTER REPAIRS, SASH	7.	EXTERIOR WOOD STOP TO REMAIN IN-PLACE. REMOVE EXISTING HARDWARE ITEMS FROM WINDOW SASH,	INTEGRITY OF THE WORK TO BE RETAINED. 19. ON ANY EXISTING SURFACE IDENTIFIED WHERE WORK IS TO BE	
)	2'-8" X 10'-0" 2'-8" X 10'-0" 2'-8" X 10'-0"	DH 12/15 DH 12/15 DH 12/15		108 3'- 109 3'-	7-8" X 7'-0" 7-8" X 7'-0" 7-8" X 7'-0"	DH DH	12/12 12/12 12/12	WINDOW SCHEDULE - ABBREVIATIONS	-	FRAME AND SILL (LIFTS, LOCKS, FLASHING, GUIDES, ETC.). REMOVE ALL NAILS, STAPLES, SCREWS, ABANDONED HARDWARE, ETC. FROM SASH AND FRAME ON BOTH INTERIOR AND EXTERIOR SURFACES. FILL ALL HOLES AFTER PAINT REMOVAL.	DONE, ALL PAINT HAS BEEN CLASSIFIED AS LEAD—CONTAINING. PROTECT ALL PERSONNEL WITHIN THE WORK AREA BY COMPLYING WITH APPLICABLE LAWS AND REGULATIONS.	
<u>2</u> 3	2'-8" X 10'-0" 2'-8" X 10'-0"	DH 12/15 DH 12/15	3 1 3	111 3'- 112 3'-	7-8" X 7'-0" 7-8" X 7'-0" 7-8" X 7'-0"	DH DH DH	12/12 12/12 12/12	DH - DOUBLE HUNG CS - CASEMENT SASH	1	PROVIDE SASH LOCKS AND FINGER PULLS FOR EACH WINDOW. SASH LIFTS (TWO PER WINDOW — BOTTOM SASH) SHALL BE NO. 158E. SASH LOCKS (ONE PER WINDOW) SHALL BE NO.	20. THE EXISTING WINDOW GLAZING COMPOUND HAS NOT BEEN TESTED FOR ASBESTOS CONTAINING MATERIALS. PRIOR TO COMMENCING WORK, TESTING OF THESE MATERIALS IS	
	2'-8" X 10'-0" 3'-8" X 10'-0" 3'-8" X 10'-0"	DH 12/15 DH 16/20 DH 16/20	3 2, 3	114 3'-	7-8" X 7'-0" 7-8" X 7'-0" 7-8" X 7'-0"	DH DH DH	12/12 12/12 12/12	FS — FIXED SASH LVR — LOUVER FOS — FIXED OVAL SASH FT — FIXED TRANSOM		80D, BY CROWN CITY HARDWARE OR APPRÓVED EQUAL. ALL HARDWARE SHALL BE SOLID BRASS.	REQUIRED. IF ASBESTOS ABATEMENT PROCEDURES ARE REQUIRED FOR REMOVAL OF GLAZING. PROTECT PERSONNEL WITHIN THE WORK AREA BY COMPLYING WITH APPLICABLE LAWS	APPROVED Approved
3	3'-8" X 10'-0" 3'-8" X 10'-0" 1'-10" X 4'-0"	DH 16/20 DH 16/20 CS 6 EA.	2, 3	117 3'-	7-8" X 7'-0" 7-8" X 7'-0" 7-8" X 7'-0"	DH DH DH	12/12 12/12 12/12	FFS — FIXED FAN SASH	გ. 	FOR BOTH UPPER AND LOWER SASH, REMOVE ALL PAINT FROM WINDOW SASH COMPLETE TO BARE WOOD BY THE GENTLEST MEANS POSSIBLE, REFER TO GENERAL NOTE 18. IF DIP—STRIPPING IS THE METHOD USED, TRY ON ONE WINDOW	AND REGULATIONS. 21. WINDOW HARDWARE SHALL BE BY CROWN CITY HARDWARE (www.crowncityhardware.com) OR APPROVED EQUAL. ALL NEW	FOR COMMANDER NAVFAC DATE S APPROVED
1 2 3	3'-8" X 1'-4" 3'-8" X 10'-0" 3'-8" X 10'-0"	FT 3 DH 16/20 DH 16/20	4	120 3'-	7-8" X 7'-0" 7-8" X 7'-0" 7-8" X 7'-0"	DH DH DH	12/12 12/12 12/12			BEFORE PROCEEDING WITH REMAINDER. WINDOWS OF THIS AGE (+/- 120 YEARS) MAY BE HELD TOGETHER WITH ANIMAL BASED GLUES WHICH MAY DETERIORATE OR DISSOLVE. CONTACT	HARDWARE SHALL BE SOLID BRASS. 22. ALL BRONZE JAMB AND SILL GUIDES AND INTERLOCK FLASHING	T. GALLAGH ACTIVITY - SATISFACTORY TO 07 DES JMS DRW REVIEWED BY
))	3'-8" X 10'-0" 	DH 16/20 	3, 7 6, 7 6. 7	122 2'- 123 2'-	7-8" X 7'-0" 7-8" X 7'-0" 7-8" X 7'-0"	DH DH DH	9/9 9/9 12/12			CONTRACTING OFFICER PRIOR TO COMMENCEMENT OF PAINT REMOVAL PROCESS. OPEN JOINTS AND CRACKS IN THE WOOD SHALL BE FILLED WITH EPOXY REPAIR MATERIALS. REMOVE ALL GLAZING COMPOUND, GLASS PANES AND GLAZING POINTS.	BY ACCURATE METAL WEATHER-STRIP CO. (www.accurateweatherstrip.com) OR APPROVED EQUAL. 23. EPOXY WOOD REPAIR MATERIALS SHALL BE LIQUID WOOD AND	REVIEWED BY PM/DM CHIEF ENG/ARCH J.HA
	3'-8" X 10'-0" 3'-8" X 10'-0" 3'-8" X 10'-0"	DH 16/20 DH 16/20 DH 16/20	3 2,3	125 3'- 126 3'-	7-8" X 7'-0" 7-8" X 7'-0" 7-8" X 7'-0"	DH DH	12/12 12/12 12/12 9/9		9.	AT WOOD SILL, REMOVE ALL NAILS, STAPLES, SCREWS, FLASHING, GUIDES AND ABANDONED HARDWARE. REMOVE ALL	WOOD EPOX AS MANUFACTURED BY ABATRON, INC. (www.abatron.com) OR APPROVED EQUAL.	TLANTIC FOLK, VIRGINIA
)	3'-8" X 10'-0" 3'-8" X 10'-0"	DH 16/20	1	128 2'- 129 36	7-8" X 7'-0" 6" DIA.	DH FOS	9/9 9/9 8 10 8 10			PAINT FROM THE SILL COMPLETE TO BARE WOOD BY THE GENTLEST MEANS POSSIBLE. OPEN JOINTS, CHECKS AND CRACKS IN THE WOOD SHALL BE FILLED WITH EPOXY REPAIR MATERIALS.	24. STORM WINDOWS SHALL BE THE VELV—A—LUME TYPE STORM WINDOW AS MANUFACTURED BY WEST WINDOW CORPORATION (www.westwindow.com) OR APPROVED EQUAL.	THES ENGINEERING
	3'-6" X 5'-6" 9'-6" X 3'-0"	DH 16/20 DH 9/9 FFS 22	2	131 36 132 3'-	6" DIA. 6" DIA. '-8" X 6'-0"	FOS LVR DH	8 10 11 8/12 3		10.	AT WINDOW FRAME, PROVIDE BRONZE JAMB AND SILL WEATHERSTRIPING AT OPERABLE SASH. BRONZE GUIDE		AL FACILITIES IMAND ANAVAL STATIC PH
	5'-6" X 5'-6" 3'-8" X 10'-0" 3'-8" X 10'-0"	DH 18/18 DH 16/20 DH 16/20	3	134 3'- 135 3'-	7-8" X 7'-0" 7-8" X 6'-0" 7-8" X 6'-0"	DH DH DH	12/12 8/12 8/12			PROFILES AS MFR. BY ACCURATE METAL WEATHER—STRIP CO. CUT GROOVE INTO SASH TO RECEIVE BRONZE JAMB AND SILL GUIDES WHERE GROOVES DO NOT EXIST. ALIGN GUIDES WITH EXISTING GROOVES. AT MEETING RAIL, REMOVE EXISTING		NG CON ER RS - E
	2'-8" X 10'-0" 2'-8" X 10'-0"	DH 12/15 DH 12/15	1, /	137 3'-	7-8" X 7'-0" 7-8" X 6'-0" 6" DIA.	DH DH FOS	12/12 8/12 8 12			INTERLOCK FLASHING AND REPLACE, REFER TO WINDOW DETAILS ON SHEET A-502.		GINEERING FOLK SS CENTER REPAIR
	2'-8" X 10'-0" 2'-8" X 10'-0"	DH 12/15 DH 12/15	8						11.	AFTER COMPLETE REMOVAL OF THE GLAZING COMPOUND, REMOVE GLASS PANES AND SAVE FOR REINSTALLATION. REPLACE DAMAGED GLASS WITH SIMILAR SIZE AND COLOR. PRIOR TO REINSTALLING, PROVIDE A BEAD OF GLAZING		SENCE SENCE SINES
	2'-8" X 7'-0" 2'-8" X 7'-0" 3'-8" X 7'-0"	DH 9/9 DH 9/9 DH 12/12	5							COMPOUND AROUND THE RABBET TO SEAL THE GLASS, THEN INSTALL GLAZING POINTS. APPLY FINAL GLAZING COMPOUND BEVELED TO COMPLETE THE SEAL. ALLOW THE GLAZING		TOF THE NAV FACILITIE SOADS IPT ~ F NAVAL BL
	3'-8" X 7'-0" 3'-8" X 7'-0" 2'-8" X 7'-0"	DH 12/12 DH 12/12 DH 9/9	5						12.	COMPOUND TO CURE COMPLETELY BEFORE PAINTING THE SASH. PRIME BARE WOOD AND PROVIDE TWO FINISH COATS OF OIL BASED PAINT OVER ALL SURFACES OF WINDOW SASH AND		DEPARTMEN NAVAL HAMPTON F
	2'-8" X 7'-0" 3'-8" X 7'-0" 3'-8" X 7'-0"	DH 9/9 DH 12/12 DH 12/12	9							FRAME. EXTEND PAINT 1/16" ONTO GLASS AT EXTERIOR SURFACES WHEN PAINTING THE GLAZING COMPOUND. PAINT COLORS FOR EXTERIOR AND INTERIOR PAINTING WILL BE		CODE ID. NO. 80091 S SCALE: AS NOTED MAXIMO NO. N STA. PROJ. NO.
	3'-8" X 7'-0" 3'-8" X 7'-0" 3'-8" X 7'-0"	DH 12/12 DH 12/12 DH 12/12	9 5						13.	SELECTED BY PWD. AT MEETING RAIL OF TOP AND BOTTOM SASH, REPAIR DAMAGED WOOD WITH EROXY REPAIR MATERIALS ALICAL METAL		WORK ORDER NO. 57 CONSTR. CONTR. NO. N/A NAVFAC DRAWING NO.
	3'-8" X 7'-0" 3'-8" X 7'-0" 3'-8" X 7'-0"	DH 12/12 DH 12/12								WOOD WITH EPOXY REPAIR MATERIALS. ALIGN METAL INTERLOCKING WEATHERSTRIPING TO OBTAIN SEAL.		12,510,75 SHEET 5 OF A-50
	J−0 X /−U	DH 12/12 1				7		<u> </u>		<u></u>	<u> </u>	DRAWFORM REVISION: 30

